
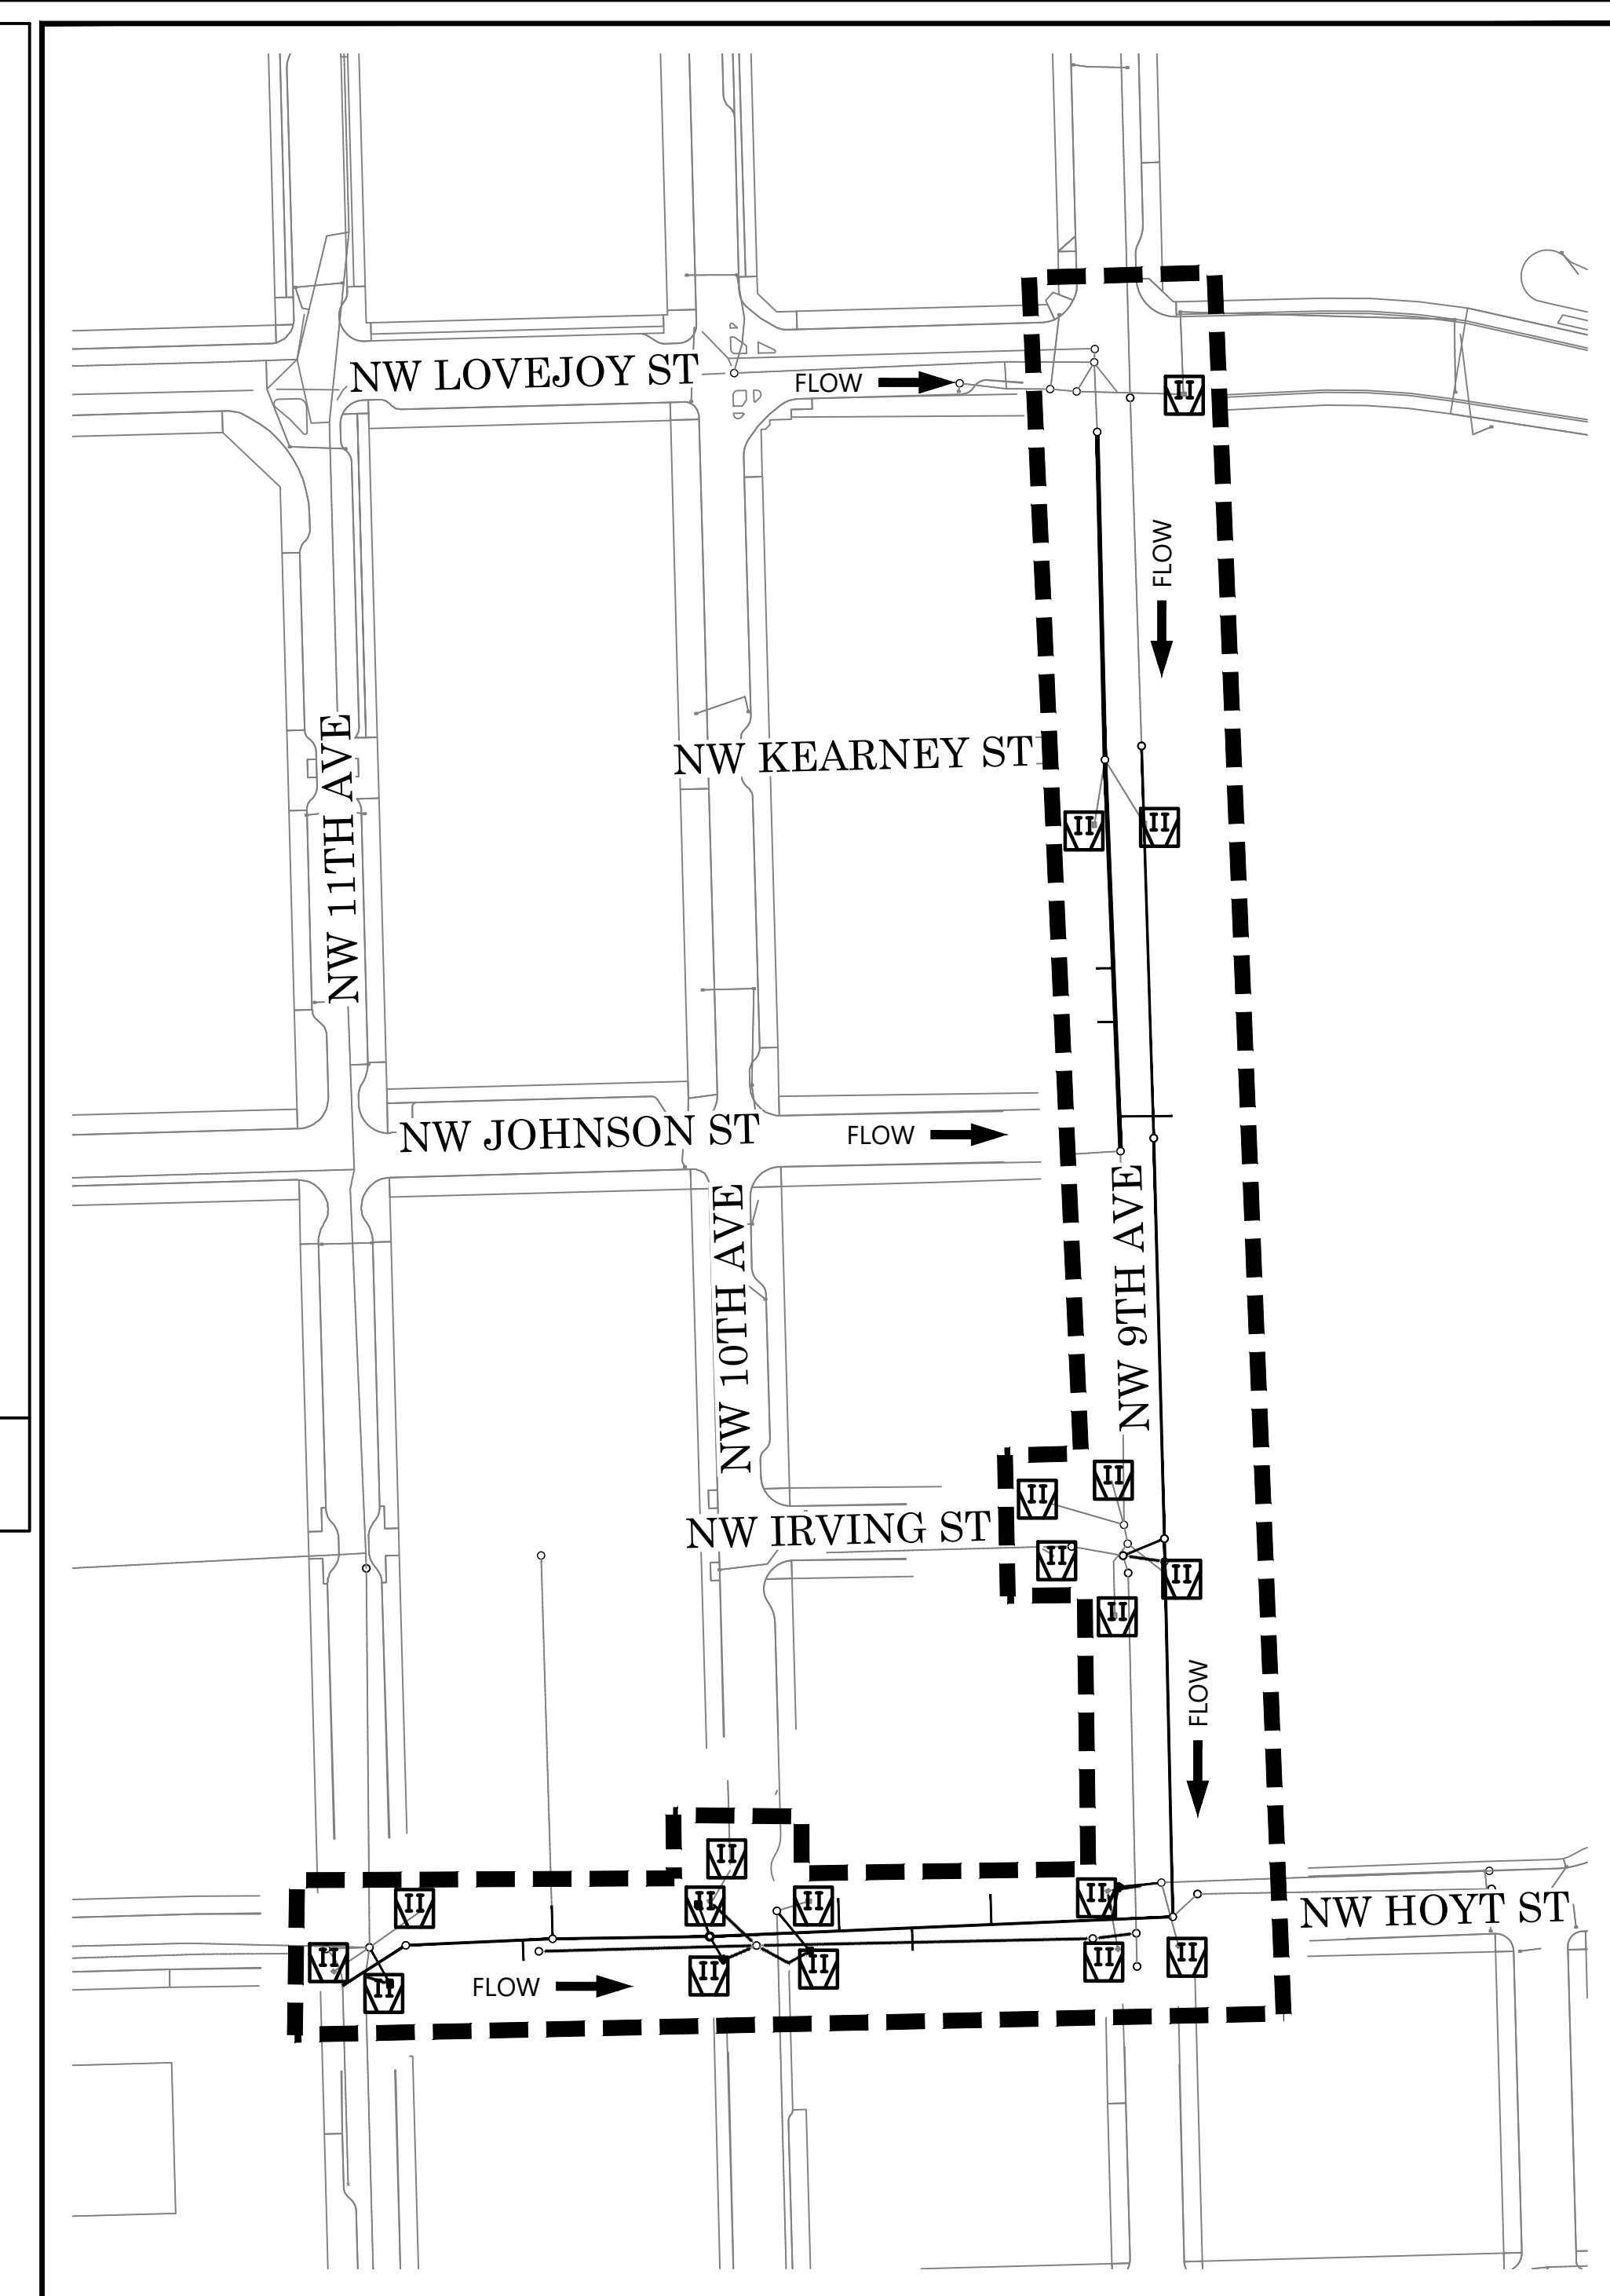
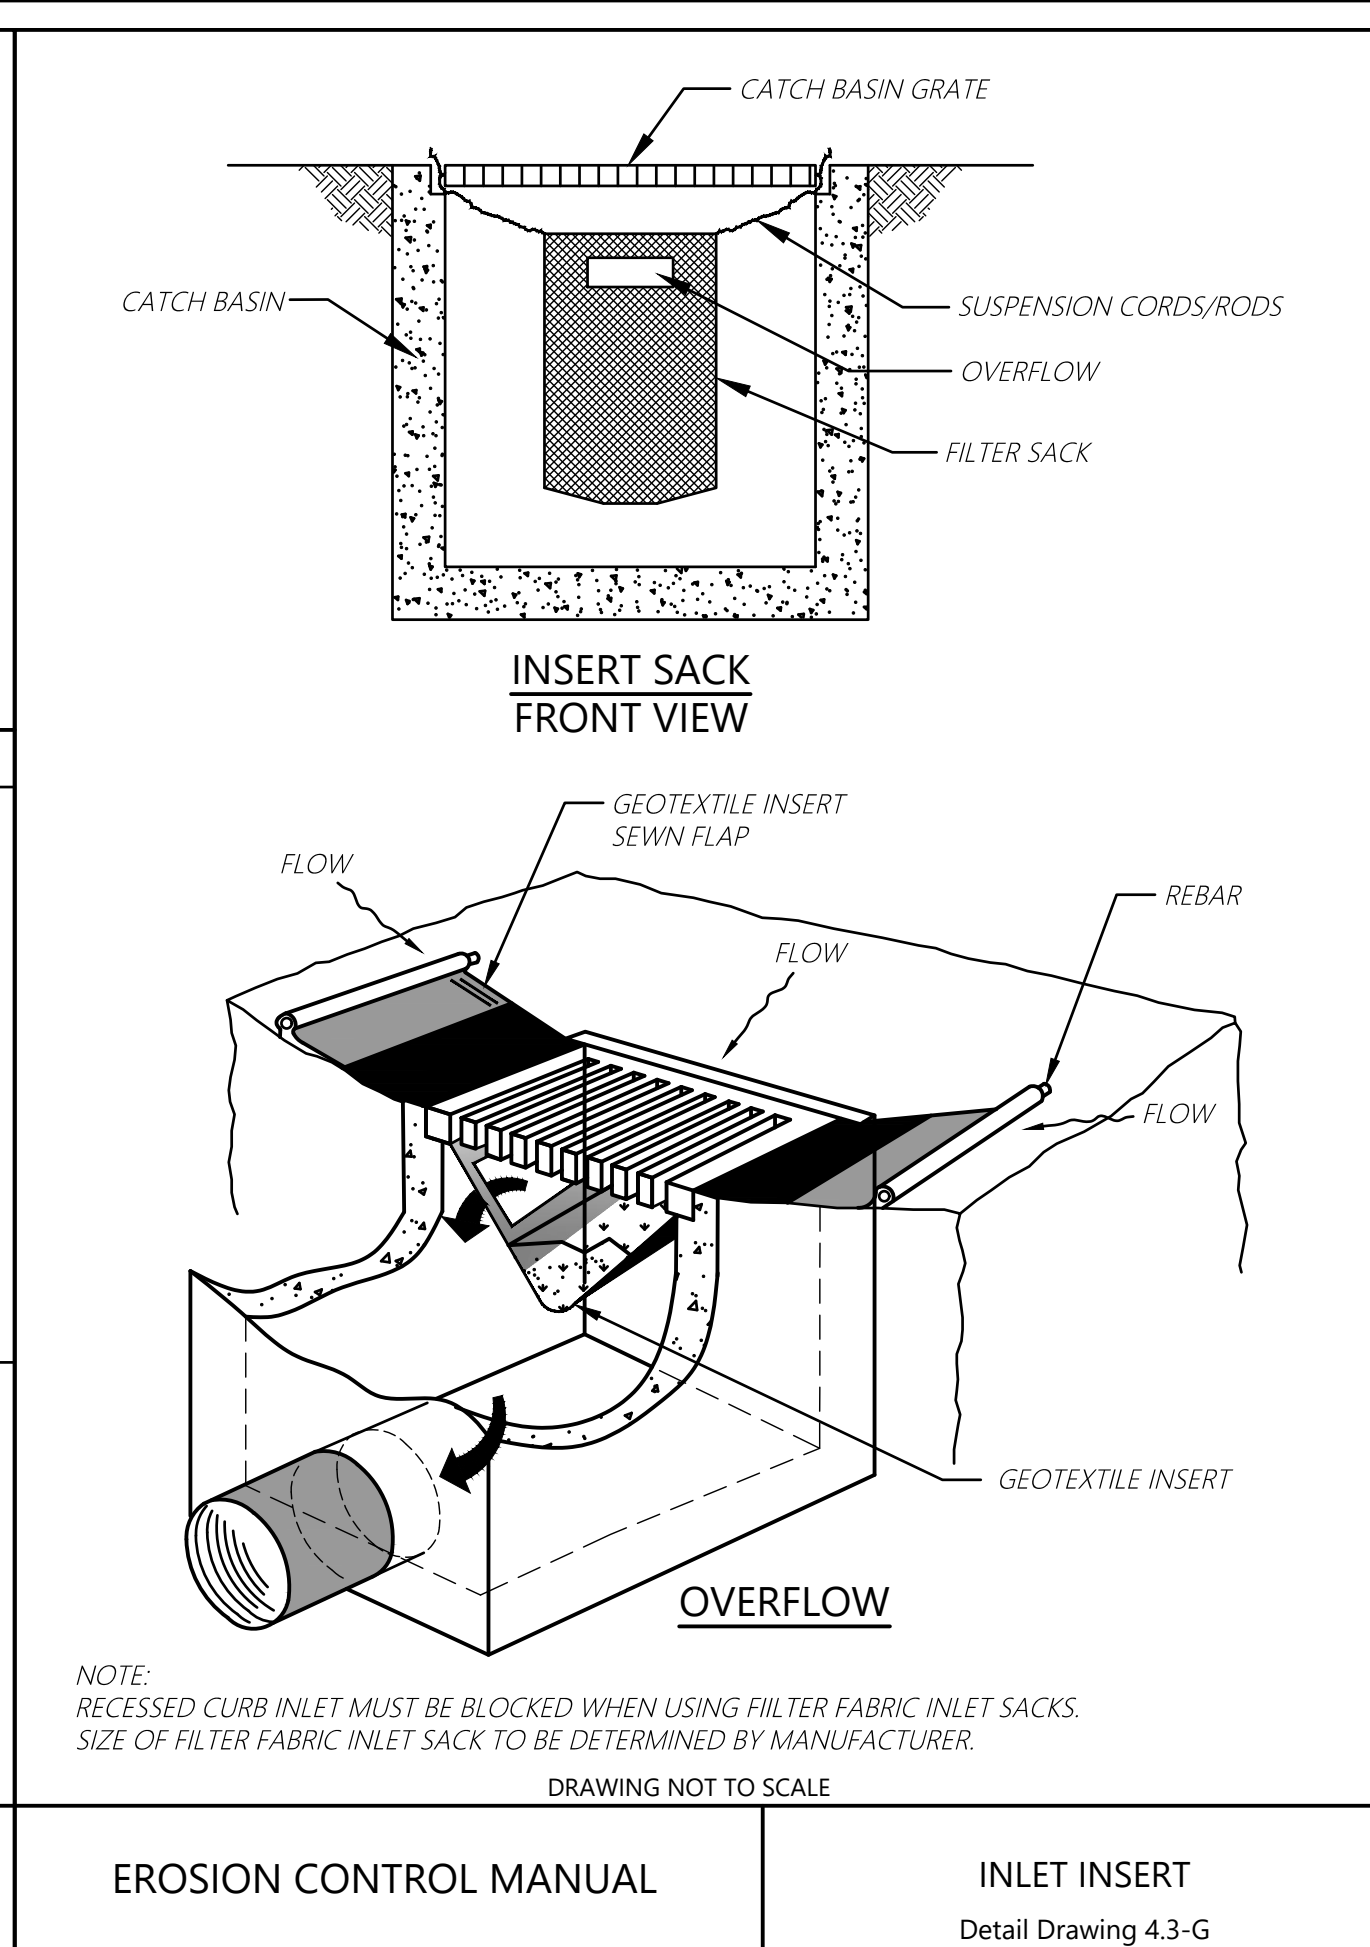
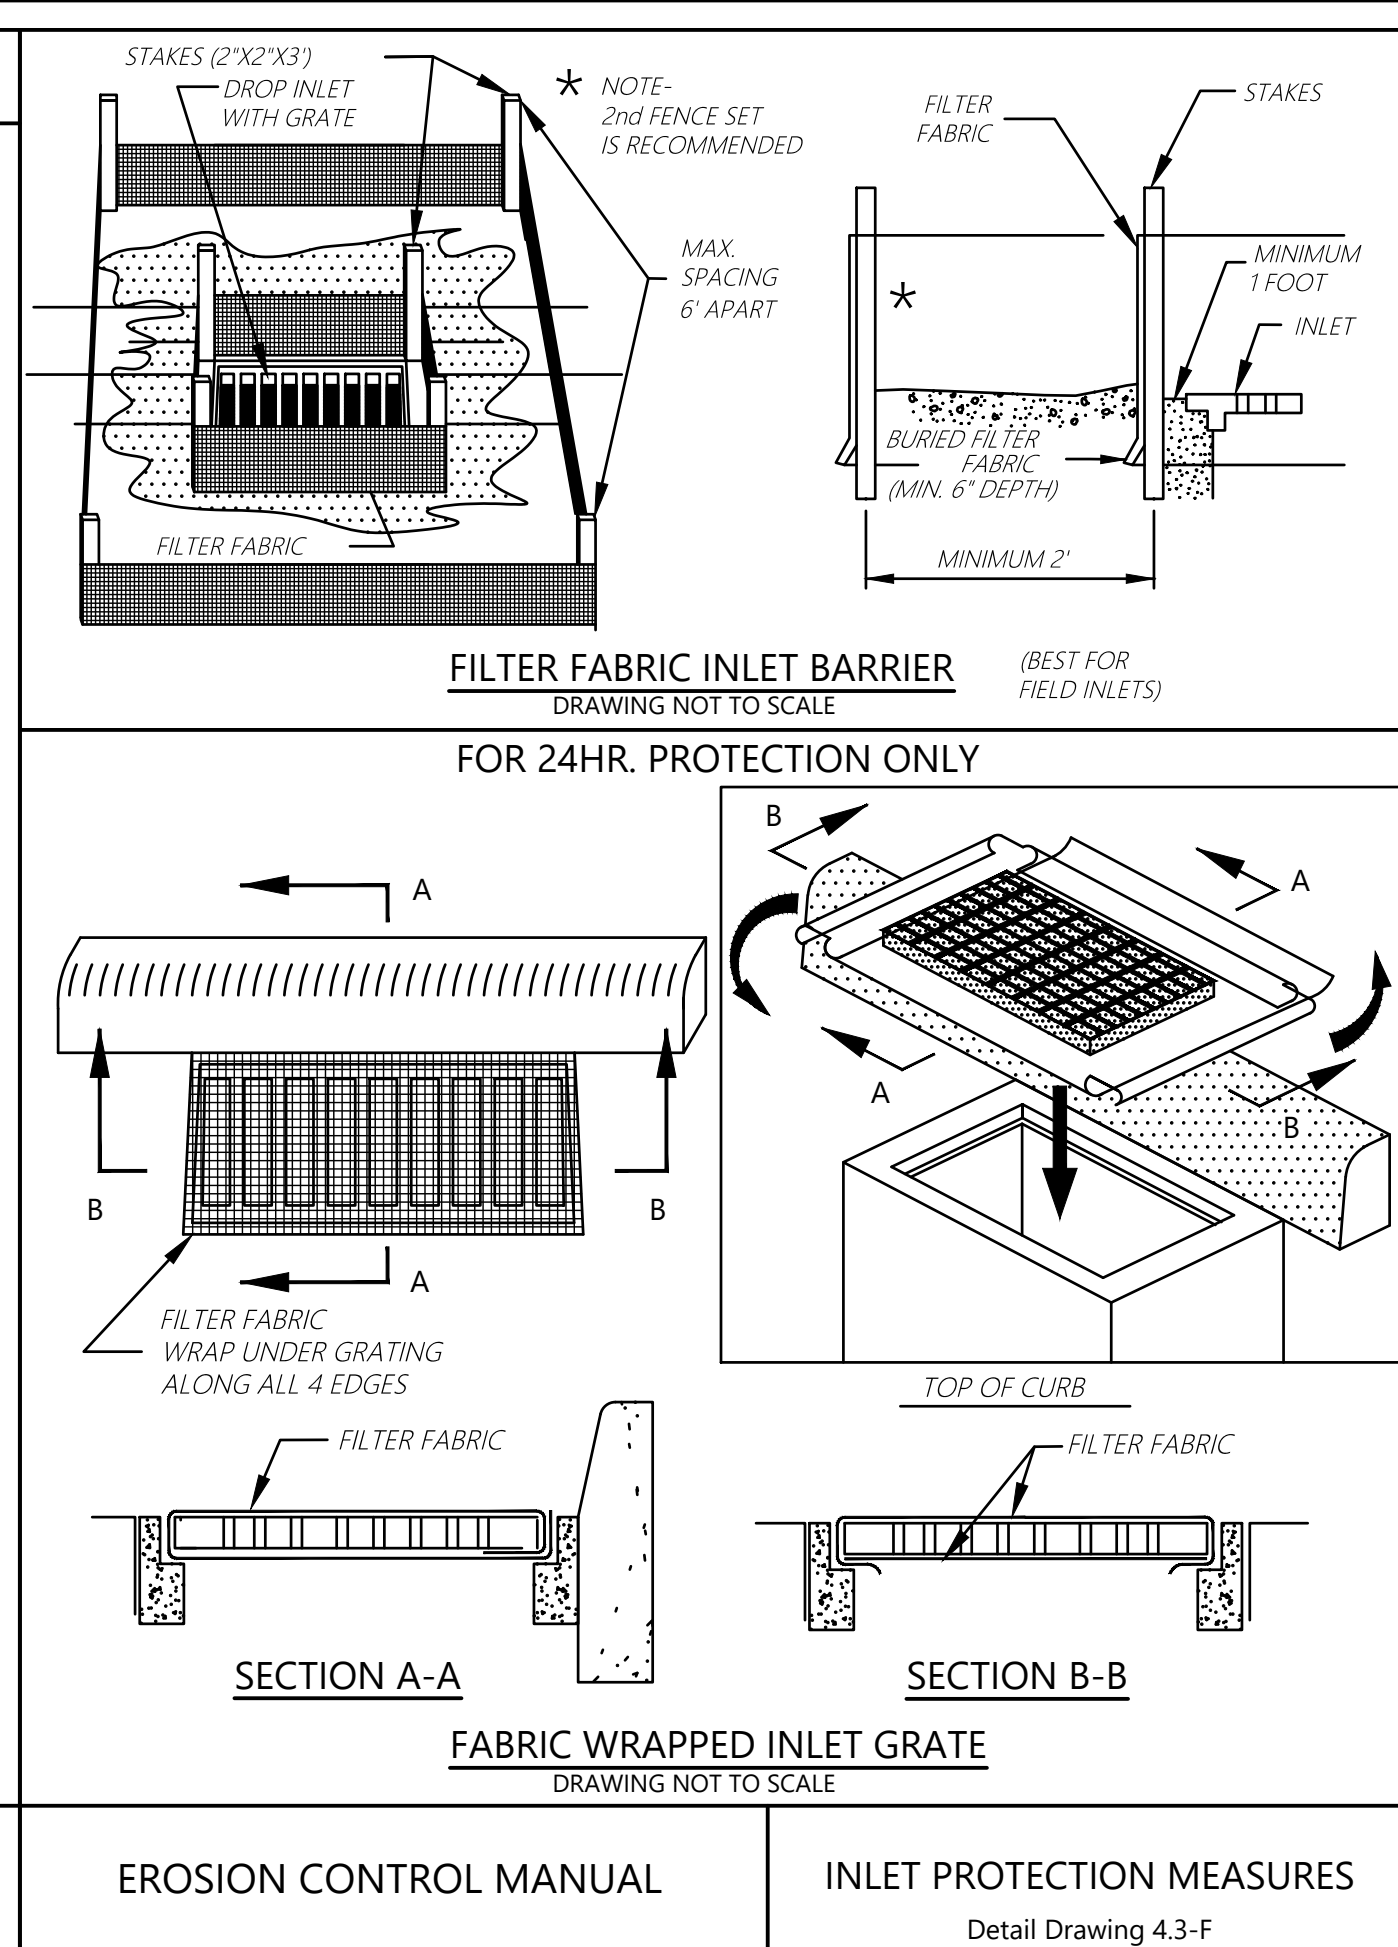


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GENERAL NOTES FOR EROSION AND SEDIMENT CONTROL:

1. EROSION AND SEDIMENT CONTROL IS REQUIRED FOR THIS PROJECT.
2. PREPARE AN EROSION AND SEDIMENT CONTROL PLAN (ESCP) BEFORE BEGINNING WORK. KEEP A COPY OF THE ESCP AND THE CITY EROSION AND SEDIMENT CONTROL MANUAL (MARCH 2008) ON SITE AT ALL TIMES DURING THE PROJECT.
3. THE EROSION AND SEDIMENT CONTROL FACILITIES SHOWN ON THIS PLAN ARE THE MINIMUM REQUIREMENTS FOR THE ANTICIPATED SITE AND SEASONAL CONDITIONS. UPGRADE THESE FACILITIES TO ADDRESS CHANGING WORK OR WEATHER CONDITIONS.
4. SELECT BEST MANAGEMENT PRACTICES (BMPs) FROM THE FOLLOWING DOCUMENTS:
 - 1) THE CITY OF PORTLAND EROSION AND SEDIMENT CONTROL MANUAL
 - 2) THE STANDARD CONSTRUCTION SPECIFICATIONS
 - 3) THE PROJECT SPECIAL PROVISIONS.
5. INSTALL, MONITOR, REPLACE AND UPGRADE ALL FACILITIES AND MEASURES. PERFORM MAINTENANCE TO ENSURE THEIR CONTINUED FUNCTIONING.
6. INSPECT AND MAINTAIN ALL FACILITIES AND MEASURES UNTIL WORK AREAS ARE RESURFACED OR STABILIZED.
7. COMPLETE AN EROSION CONTROL MONITORING FORM AFTER EACH INSPECTION. INCLUDE THE INSPECTION DATE AND TIME. RETAIN THESE COMPLETED FORMS ON SITE AND PROVIDE THEM UPON REQUEST.
8. NO VISIBLE AND MEASURABLE SEDIMENT SHALL EXIT THE SITE, ENTER A PUBLIC RIGHT-OF-WAY, OR BE DEPOSITED INTO ANY WATER BODY OR STORM DRAINAGE SYSTEM.
9. FOLLOWING A STORM EVENT, INSPECT AND ADJUST, REPAIR, IMPROVE, OR REPLACE ALL DEFICIENT OR FAILING FACILITIES AND MEASURES.
10. PROTECT ALL FUNCTIONING STORM WATER INLETS AND CATCH BASINS FROM RECEIVING UNFILTERED SEDIMENT-LADEN RUNOFF.
11. REMOVE SEDIMENT AND DEBRIS FROM INLETS AND CATCH BASINS BEFORE PAVING. DO NOT FLUSH SEDIMENT-LADEN WATER INTO THE DOWNSTREAM SYSTEM.
12. STABILIZE ALL EXPOSED SOIL IMMEDIATELY FOLLOWING GROUND DISTURBING ACTIVITY.
13. STABILIZE AND PROTECT STOCKPILED SOIL WITH APPROVED MEASURES.
14. REMOVE EROSION AND SEDIMENT CONTROL FACILITIES AFTER THE PROJECT IS COMPLETED AND ACCEPTED.

PROJECT AREA
SCALE 1:100

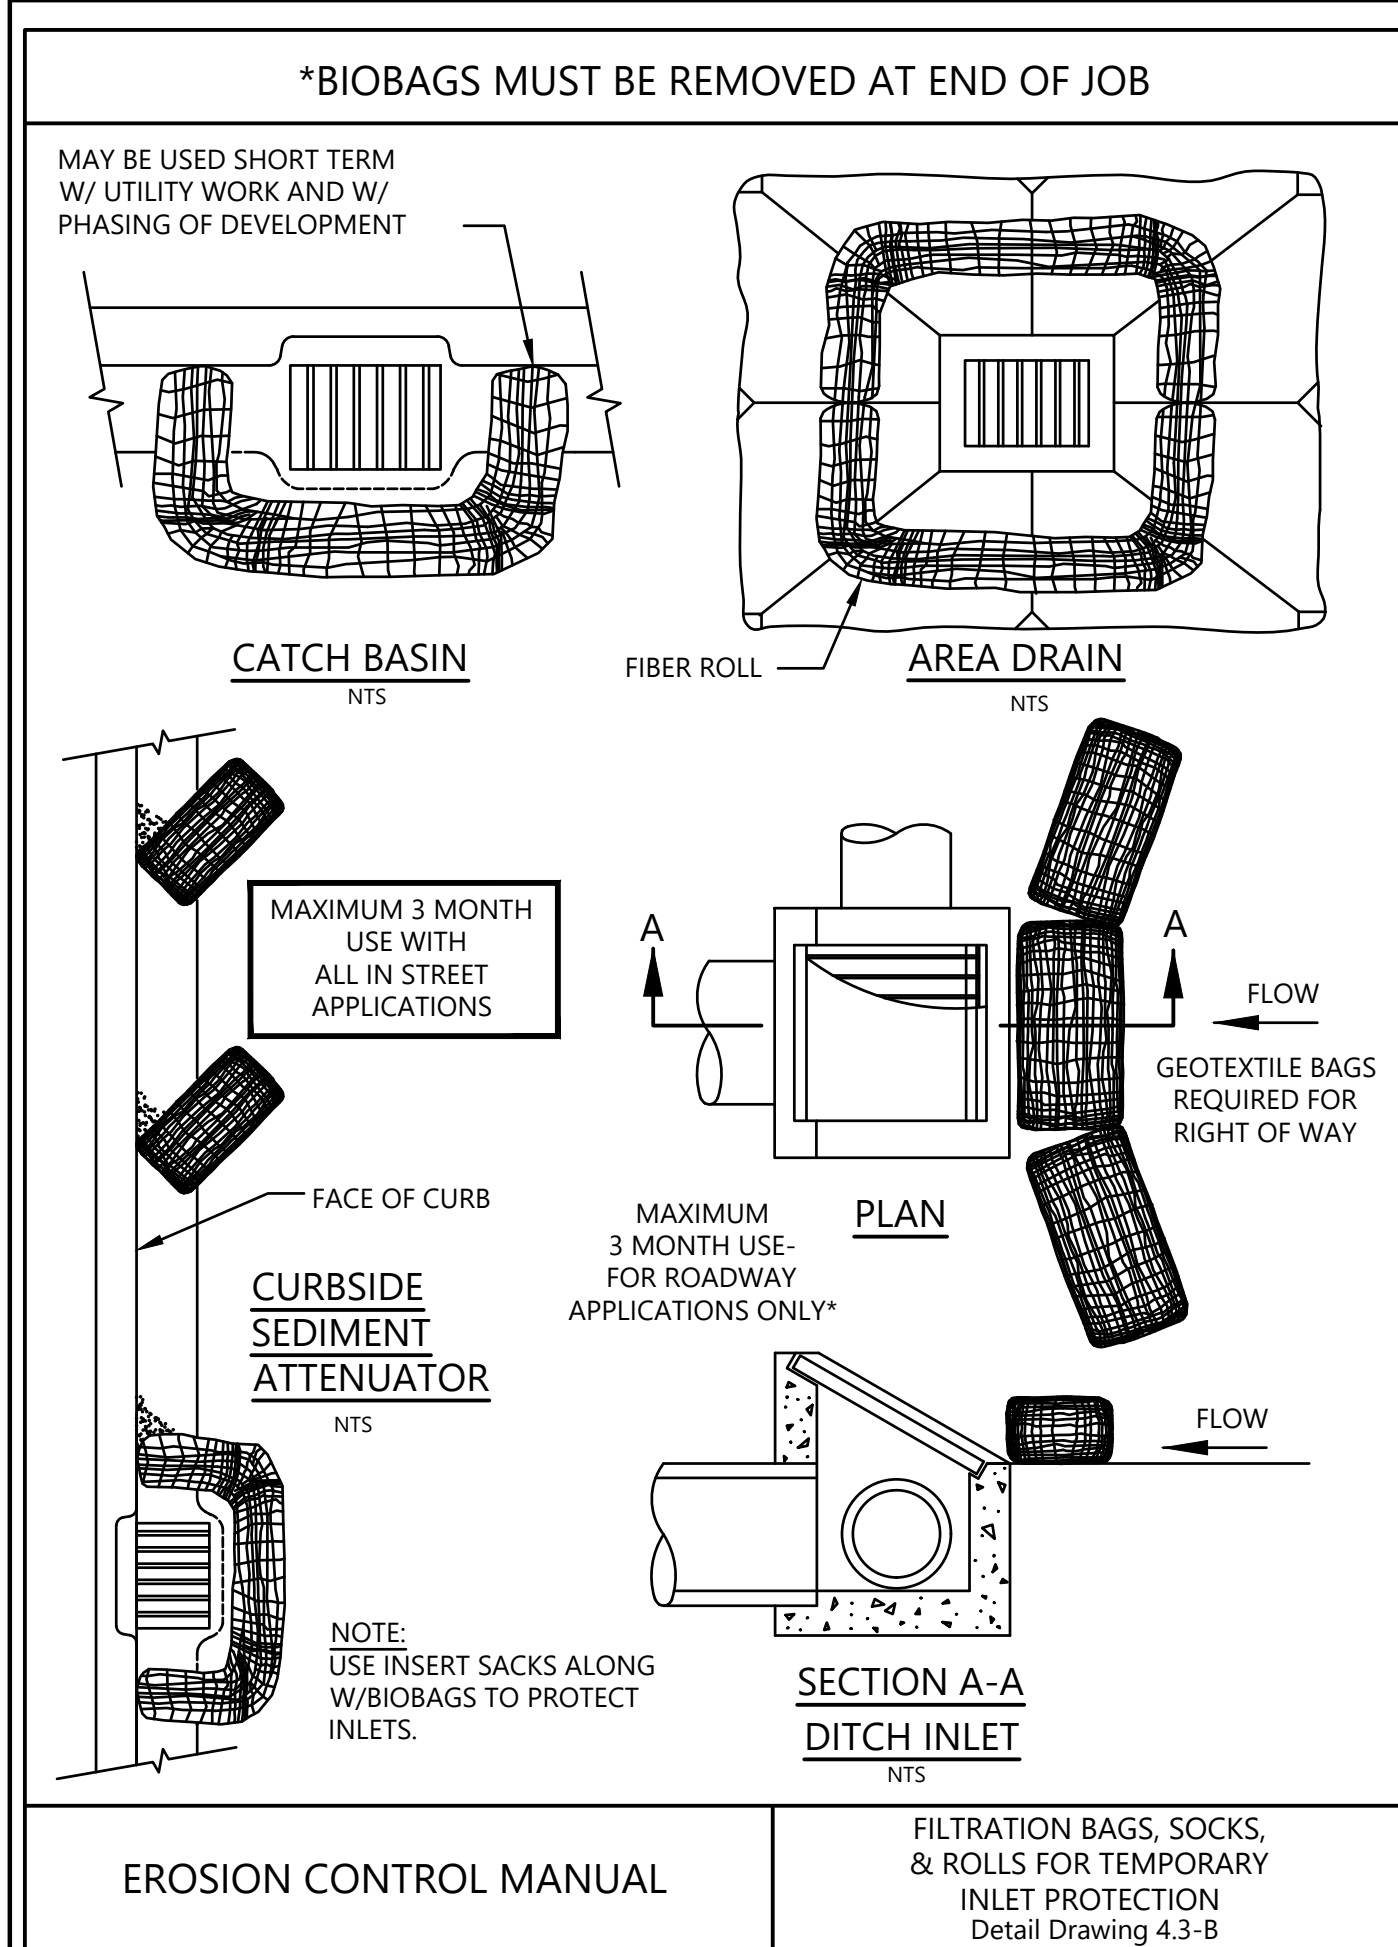

LEGEND:

- INLET PROTECTION
- SURFACE WATER FLOW
- EROSION CONTROL BOUNDARY

NO.	DATE	DESCRIPTION	APPD.
REVISION			
XREF(S) USED: E11252_XDSGNE11252_XBMAP			
ROTATION ANGLE: 0d0'0"			
CONSTRUCTED BY: _____			
PROJECT COMPLETED: _____			
MAP CORRECTED BY: _____ CHECKED BY: _____			
DRAWING NAME: E11252_CE-SHEETS.dwg			
DESIGNED BY	DATE APPROVED	DRAWN BY	ENGR. SUPV.
CHECKED BY	ENGR. DIV. MGR.	CONST. DIV. MGR.	

CITY OF PORTLAND
ENVIRONMENTAL SERVICES



DRAFT
60%

NW 9TH AVE / HOYT ST
SYSTEM IMPROVEMENTS

EROSION CONTROL PLAN, DETAILS, AND NOTES

1/4 SECTION
2929
JOB NO.
E11252
SHEET NO.
CE01
13 OF 17