


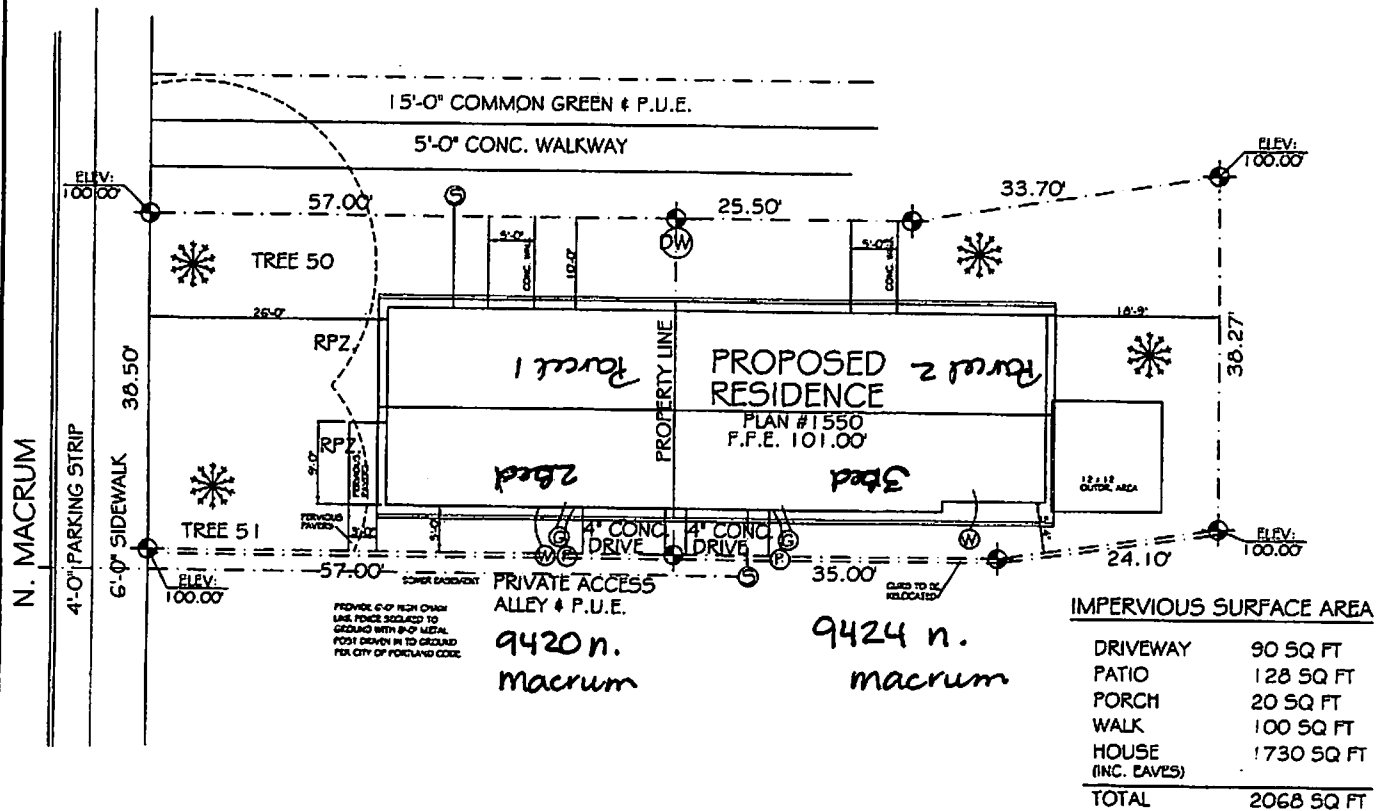

LOT 7 CALVERT FARMS



LANDSCAPE
 ** PRECISE LOCATION AND SPECIES TO BE DETERMINED IN FIELD BY CONTRACTOR

- F - FLOWERING PEAR (2" CALIPER)
"PYRUS CALLERYANA"
- D - DOUGLAS FIR (2" CALIPER)
"PSEUDOTSUGA MENZIESII"
- R - RED MAPLE (2" CALIPER)
"ACER RUBRUM"
- P - PACIFIC DOGWOOD (2" CALIPER)
"C. NUTTALLI"

- TREE MIN 2" CALIPER 6' TALL @ PLANTING
- SHRUBS AT LEAST 1-GALLON SIZE @ PLANTING
- EDGING BOXWOOD "BUXUS SEMPERVIRENS"
- BUNALD SPIRAEA "SPIRAEA X BUNALDA CVS."
- DAVID VIBURNUM "VIBURNUM DAVIDI"

- REQUIRED MANUAL WATERING FOR THE FIRST YEAR

- ENTIRE SITE COVERED IN:**
- GROUND COVER
 - KINKIKINNICK, BEARBERRY "ARCTOSTAPHYLOS UVA URSI"
 - SUN ROSE "HELIANTHEMUM CVS."
 - BARK DUST
 - MULCH
 - RIVER ROCK
 - GRASS (WESTERN FESCUE)

NO IRRIGATION (SELF WATERING)

LEGEND	
⊙	3" SEWER
⊗	1" WATER
⊕	GAS
⊖	POWER
---	RAIN DRAIN

IT IS THE SOLE RESPONSIBILITY OF THE CLIENT TO VERIFY ALL SITE CONDITIONS, INCLUDING ANY UTILITIES PLACED ON THE SITE, AND INFORM CHANGES OF ANY POTENTIAL FIELD MODIFICATIONS.

TROXEL'S HOME DESIGN

SCALE: 1" = 10.00' 1775 SW 26TH CT. DESIGNED BY: DENNIS TROXEL


DATE: 1/18/16 GRESHAM, OREGON 97030 (503) 625-3034

NAME: _____ LOT: _____

ADDRESS: LOT 7 CALVERT FARMS


THIS PLAN SET HAS BEEN AUTHORIZED FOR USE CONSTRUCTION OF ONE BUILDING BY THE ORIGINAL PURCHASER. AUTHORIZED COPIES OF THIS PLAN MUST HAVE A RED INKED STAMP ON ALL SHEETS.

SHEET: 1 PLAN NUMBER: _____

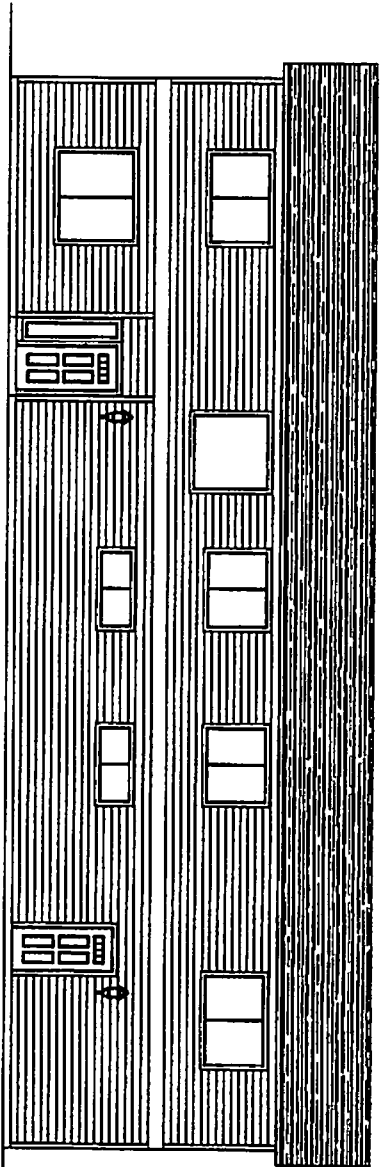


FRONT ELEVATION
SCALE: 1/4" = 1'-0"

CITY OF PORTLAND INFO:
 FRONT WALL HEIGHT AND FROM DE
 APPL. HORIZ. = 135"
 FRONT WALL HGT. = 1270.0 S.F.
 FRONT WALL AREA = 1917.7 S.F.
 REAR WALL HEIGHT = 211.0 S.F.

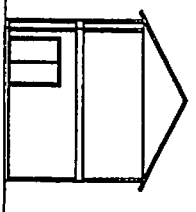


LEFT ELEVATION
SCALE: 1/8" = 1'-0"

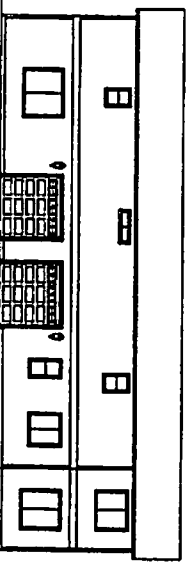

REAR ELEVATION
SCALE: 1/8" = 1'-0"

CITY OF PORTLAND INFO:
 FRONT WALL HEIGHT AND FROM DE
 APPL. HORIZ. = 135"
 FRONT WALL HGT. = 1270.0 S.F.
 FRONT WALL AREA = 1917.7 S.F.
 REAR WALL HEIGHT = 211.0 S.F.

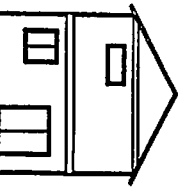

RIGHT ELEVATION
SCALE: 1/8" = 1'-0"

TROXEL'S HOME DESIGN


SCALE: AS SHOWN	DATE: 04/11/2010	PROJECT: 441 S.F.	DRIVING 1800L
DATE: 04/11/2010	PROJECT: 441 S.F.	DRIVING 1800L	10/10/10
DATE: 04/11/2010	PROJECT: 441 S.F.	DRIVING 1800L	10/10/10

PROJECT: 441 S.F. TOTAL 4371 S.F. LITRES 420 S.F. 1069 S.F.
 SHEET: 1 PLAN NUMBER: 41590


TROXEL'S HOME DESIGN
 DRAWN BY: [Name]
 CHECKED BY: [Name]
 DATE: [Date]
 SCALE: AS SHOWN
 PROJECT NO.: [Number]
 SHEET: 3 OF 3
 PLAN NUMBER: [Number]
 #1590

CROSS SECTION A-A

SCALE: 1/4" = 1'-0"

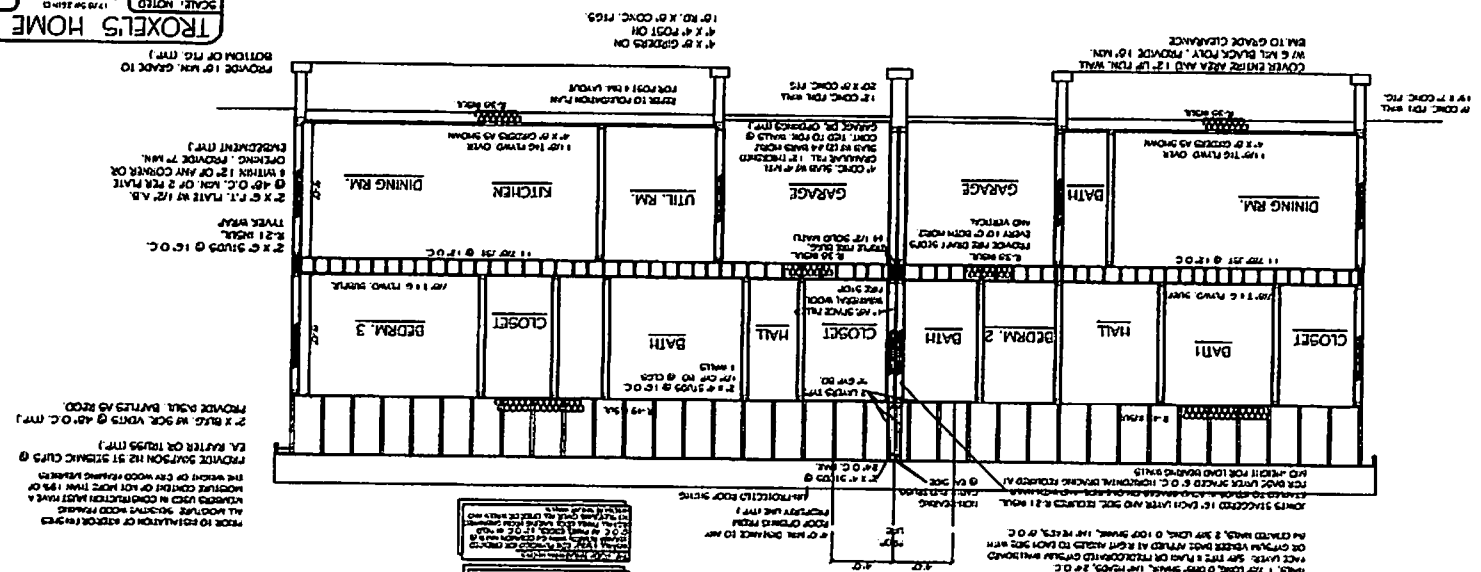

INTERMEDIATE FRAMING
 FOR EXTERIOR WALLS
 STUDS & JOIST
 TO BE SPACED AT 16" O.C.
 TO PROVIDE PROPER
 SUPPORT FOR EXTERIOR
 WALLS & CEILING JOISTS.
 ALL EXTERIOR WALLS
 SHALL BE FULLY
 INSULATED WITH
 2\"/>

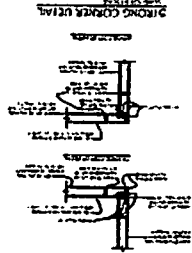


GA FILE NO. WF 3820 59 TO 59 STC


CROSS SECTION B-B

SCALE: 1/4" = 1'-0"

PROVIDE 1\"/>

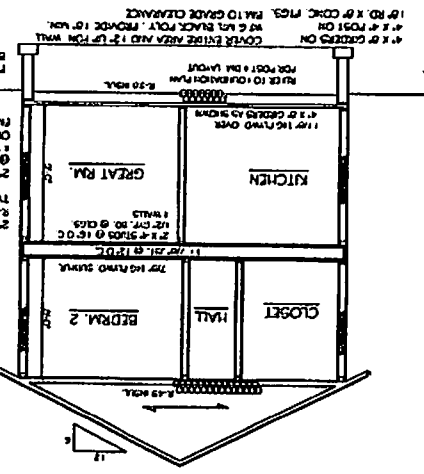

PROVIDE 1\"/>

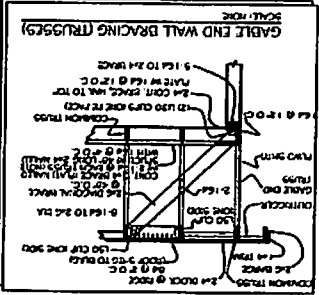

PROVIDE 1\"/>

PROVIDE 1\"/>

PROVIDE 1\"/>

